

COUNCIL OF THE ISLES OF SCILLY

Old Wesleyan Chapel, Garrison Lane, St Mary's Isles of Scilly TR21 0JD Telephone: 01720 424455 – Email: planning@scilly.gov.uk

Town and Country Planning Act 1990 Town and Country Planning (Development Management Procedure) Order 2015

PERMISSION FOR DEVELOPMENT

Application P/23/097/HH No: Date Application Registered:

19th February 2024

- Applicant: Mr And Mrs Woodcock 4 Porthcressa Terrace Hugh Town St Mary's Isles of Scilly TR21 0JW
- Site address:4 Porthcressa Terrace Hugh Town St Mary's Isles of Scilly TR21 0JWProposal:Demolition of existing single storey extension and replace with larger extension
on rear elevation, removal of existing rear dormer window and replace with a
larger rear dormer window, replace scantle roof slates with new dry laid slates.

In pursuance of their powers under the above Act, the Council hereby **PERMIT** the above development to be carried out in accordance with the following Conditions:

C1 The development hereby permitted shall be begun before the expiration of three years from the date of this permission.

Reason: In accordance with the requirements of Section 91 of the Town and Country Planning Act 1990 (as amended by Section 51 of the Planning and Compulsory Purchase Act 2004).

- C2 The development hereby permitted shall be carried out in accordance with the approved details only including:
 - Plan 1 Location Plan received 14.02.2024.
 - Plan 2 Proposed Block Plan, drawing no: DC_XXX_000_06101_P0, received 14.02.2024.
 - Plan 3 Proposed Ground Floor Plans, drawing no: DC_XXX_000_02101_P02, received 16.02.2024.
 - Plan 4 Proposed First Floor Plans, drawing no: C_XXX_001_02102_P02, received 16.02.2024.
 - Plan 5 Proposed Roof Plan, drawing no: DC_XXX_R1_02103_P01, received 16.02.2024.
 - Plan 6 Proposed Rear Elevation Amended, drawing no: DC_ZZZ_XXX_04101_P03, received 08.04.2024.
 - Plan 7 Proposed Side Elevation Amended, drawing no: DC_ZZZ_XXX_04102_P03, received 08.04.2024.
 - Plan 8 Design and Access Statement received 14.02.2024.
 - Plan 9 Bat Survey, reference 23-10-1
 - Plan 10 Site Waste Management Plan received 14.02.2024.

These are stamped as APPROVED.

Reason: For the clarity and avoidance of doubt and in the interests of the character and appearance of the Conservation Area, Area of Outstanding Natural Beauty and Heritage Coast in accordance with Policy OE1 and OE7 of the Isles of Scilly Local Plan (2015-2030).

C3 The materials used in the construction of the development hereby approved shall be as detailed within the permitted application particulars and shall be retained permanently as such, unless prior written consent is obtained from the Local Planning Authority to any variation.

Reason: To safeguard the appearance of the building and the character of the area.

C4 Notwithstanding the provisions of the Town and Country Planning (General Permitted Development) Order 2015, (or any order revoking or re-enacting that Order) prior to installation, details of any external lighting shall be submitted to, and approved in writing by, the Local Planning Authority. The lighting shall be appropriately cowled or down-lit and controlled with a sensor. Any external lighting shall thereafter be installed in accordance with the agreed details only.

Reason: To protect the amenities of the locality, including those of neighbouring residential properties and to preserve the dark night skies of the Isles of Scilly as an Area of Outstanding Natural Beauty and the Garrison Dark Sky Discovery Site (Milky Way Class) in accordance with Policy OE4 of the Isles of Scilly Local Plan (2015-2030).

C5 The development hereby approved shall be undertaken in accordance with the Precautionary Method Statement contained with the Preliminary Roost Assessment (23-10-1) dated 28th October 2023.

Reason: In the interests of protecting the residential amenities of the islands.

C6 No construction plant and/or machinery shall be operated on the premises, as part of the implementation of this permission, before 0800 hours on Mondays through to Saturdays nor after 1800 hours. There shall be no works involving construction plant and/or machinery on a Sunday or Public or Bank Holiday.

Reason: In the interests of protecting the residential amenities of the islands.

Further Information

- 1. In dealing with this application, the Council of the Isles of Scilly has actively sought to work with the applicants in a positive and proactive manner, in accordance with paragraph 38 of the National Planning Policy Framework 2023.
- 2. In accordance with the provisions of Section 96A of the Town and Country Planning Act which came into force on 1st October 2009, any amendments to the approved plans will require either a formal application for a non-material amendment or the submission of a full planning application for a revised scheme. Please discuss any proposed amendments with the Planning Officer. There is a fee to apply for a non-material amendment and the most up to date fee will be charged which can be checked here: https://ecab.planningportal.co.uk/uploads/english_application_fees.pdf
- 3. The Applicant is reminded of the provisions of the Wildlife and Countryside Act 1981 and the E.C. Conservation (Natural Habitats) Regulations Act 1994, the Habitat and Species Regulations 2012 and our Natural and Environment and Rural Communities biodiversity duty. This planning permission does not absolve the applicant from complying with the relevant law protecting species, including obtaining and complying with the terms and conditions of any licences required, as described in part IV B of Circular 06/2005. Care should be taken during the work and if bats are discovered, they should not be handled, work must stop immediately and a bat warden contacted. Extra care should be taken during the work, especially when alterations are carried out to buildings if fascia boards are removed as roosting bats could be found in these areas. If bats are found to be present during work, they must not be handled. Work must stop immediately, and advice sought from licensed bat wardens. Call The Bat Conservation Trust's National Bat Helpline on 0845 1300 228 or Natural England (01872 245045) for advice.
- 4. This decision is not a determination under the Building Regulations. Please ensure that all building works accord with the Building Regulations and that all appropriate approvals are in place for each stage of the build project. You can contact Building Control for further advice or to make a building control application: buildingcontrol@cornwall.gov.uk.

hult Signed:

Chief Planning Officer Duly Authorised Officer of the Council to make and issue Planning Decisions on behalf of the Council of the Isles of Scilly.

DATE OF ISSUE: 12th April 2024



COUNCIL OF THE ISLES OF SCILLY

Planning Department Town Hall, The Parade, St Mary's, Isles of Scilly, TR21 OLW 20300 1234 105 2planning@scilly.gov.uk

Dear Mr and Mrs Woodcock

Please sign and complete this certificate.

This is to certify that decision notice: P/23/097/HH and the accompanying conditions have been read and understood by the applicant: Mr and Mrs Woodcock.

- 1. **I/we intend to commence the development as approved:** Demolition of existing single storey extension and replace with larger extension on rear elevation, removal of existing rear dormer window and replace with a larger rear dormer window, replace scantle roof slates with new dry laid slates at: 4 Porthcressa Terrace Hugh Town St Mary's Isles Of Scilly TR21 0JW **on**:
- 2. I am/we are aware of any conditions that need to be discharged before works commence.
- 3. I/we will notify the Planning Department in advance of commencement in order that any pre-commencement conditions can be discharged.

You are advised to note that Officers of the Local Planning Authority may inspect the project both during construction, on a spot-check basis, and once completed, to ensure that the proposal has complied with the approved plans and conditions. In the event that the site is found to be inaccessible then you are asked to provide contact details of the applicant/agent/contractor (delete as appropriate):

Name:	Contact Telephone Number: And/Or Email:
Print Name:	
Signed:	
eigned.	
Date:	

Please sign and return to the **above address** as soon as possible.



COUNCIL OF THE ISLES OF SCILLY

Planning Department Town Hall, St Mary's, Isles of Scilly, TR21 OLW ①01720 424455

THIS LETTER CONTAINS IMPORTANT INFORMATION REGARDING YOUR PERMISSION – PLEASE READ IF YOU ARE AN AGENT DEALING WITH IS ON BEHALF OF THE APPLICANT IT IS IMPORTANT TO LET THE APPLICANT KNOW OF ANY PRE-COMMENCMENT CONDITIONS

Dear Applicant,

This letter is intended to help you advance your project through the development process. Now that you have been granted permission, there may be further tasks you need to complete. Some aspects may not apply to your development; however, your attention is drawn to the following paragraphs, which provide advice on a range of matters including how to carry out your development and how to appeal against the decision made by the Local Planning Authority (LPA).

Carrying out the Development in Accordance with the Approved Plans

You must carry out your development in accordance with the stamped plans enclosed with this letter. Failure to do so may result in enforcement action being taken by the LPA and any un-authorised work carried out may have to be amended or removed from the site.

Discharging Conditions

Some conditions on the attached decision notice will need to be formally discharged by the LPA. In particular, any condition that needs to be carried out prior to development taking place, such as a 'source and disposal of materials' condition, an 'archaeological' condition or 'landscaping' condition must be formally discharged prior to the implementation of the planning permission. In the case of an archaeological condition, please contact the Planning Department for advice on the steps required. Whilst you do not need to formally discharge every condition on the decision notice, it is important you inform the Planning Department when the condition advises you to do so before you commence the implementation of this permission. Although we will aim to deal with any application to discharge conditions as expeditiously as possible, you are reminded to allow up **to 8 weeks** for the discharge of conditions process.

Please inform the Planning Department when your development or works will be commencing. This will enable the Council to monitor the discharge and compliance with conditions and provide guidance as necessary. We will not be able to provide you with any written confirmation on the discharge of pre-commencement conditions if you do not formally apply to discharge the conditions before you start works. As with the rest of the planning application fees, central Government sets a fee within the same set of regulations for the formal discharge of conditions attached to planning permissions. Conditions are necessary to control approved works and development. Requests for confirmation that one or more planning conditions have been complied with are as follows (VAT is not payable on fees set by central government). More information can be found on the Council's website:

- Householder permissions £43 per application
- Other permissions £145 per application

Amendments

If you require a change to the development, contact the LPA to see if you can make a 'non material amendment' (NMA). NMA can only be made to planning permissions and not a listed building consent. They were introduced by the Government to reflect the fact that some schemes may need to change during the construction phase. The process involves a short application form and a 14 day consultation period. There is a fee of £43 for householder type applications and £293 in all other cases. The NMA should be determined within 28 days. If the change to your proposal is not considered to be non-material or minor, then you would need to submit a new planning application to reflect those changes. Please contact the Planning Department for more information on what level of amendment would be considered non-material if necessary.

Appealing Against the Decision

If you are aggrieved by any of the planning conditions attached to your decision notice, you can appeal to have specific conditions lifted or modified by the Secretary of State. All appeal decisions are considered by the Planning Inspectorate – a government department aimed at providing an unbiased judgement on a planning application. From the date of the decision notice attached you must lodge an appeal within the following time periods:

- Householder Application 12 weeks
- Planning Application 6 months
- Listed Building Consent 6 months
- Advertisement Consent 8 weeks
- Minor Commercial Application 12 weeks
- Lawful Development Certificate None (unless for LBC 6 months)
- Other Types 6 months

Note that these periods can change so you should check with the Planning Inspectorate for the most up to date list. You can apply to the Secretary of State to extend this period, although this will only be allowed in exceptional circumstances.

You find more information on appeal types including how to submit an appeal to the Planning Inspectorate by visiting <u>https://www.gov.uk/topic/planning-development/planning-</u> <u>permission-appeals</u> or you can obtain hard copy appeal forms by calling 0303 444 5000. Current appeal handling times can be found at: <u>Appeals: How long they take page</u>.

Building Regulations

With all building work, the owner of the property is responsible for meeting the relevant Planning and Building Regulations. Building Regulations apply to most building work so it is important to find out if you need permission. This consent is to ensure the safety of people in and around buildings in relation to structure, access, fire safety, infrastructure and appropriate insulation.

The Building Control function is carried out on behalf of the Council of the Isles of Scilly by Cornwall Council. All enquiries and Building Control applications should be made direct to Cornwall Council, via the following link <u>Cornwall Council</u>. This link also contains comprehensive information to assist you with all of your Building Control needs.

Building Control can be contacted via telephone by calling 01872 224792 (Option 1), via email <u>buildingcontrol@cornwall.gov.uk</u> or by post at:

Building Control Cornwall Council Pydar House Pydar Street Truro Cornwall TR1 1XU

Inspection Requests can also be made online: https://www.cornwall.gov.uk/planning-and-building-control/building-control/book-an-inspection/

Registering/Altering Addresses

If you are building a new dwelling, sub dividing a dwelling into flats or need to change your address, please contact the Planning Department who will be able to make alterations to local and national databases and ensure postcodes are allocated.

Connections to Utilities

If you require a connection to utilities such as water and sewerage, you will need to contact South West Water on 08000831821. Electricity connections are made by Western Power Distribution who can be contacted on 08456012989.

Should you require any further advice regarding any part of your development, please contact the Planning Department and we will be happy to help you.




Date Produced: 14-Feb-2024


APPROVED By Lisa Walton at 10:13 am, Apr 12, 2024

RECEIVED

By Liv Rickman at 3:22 pm, Feb 14, 2024


Scale: 1:1250 @A4

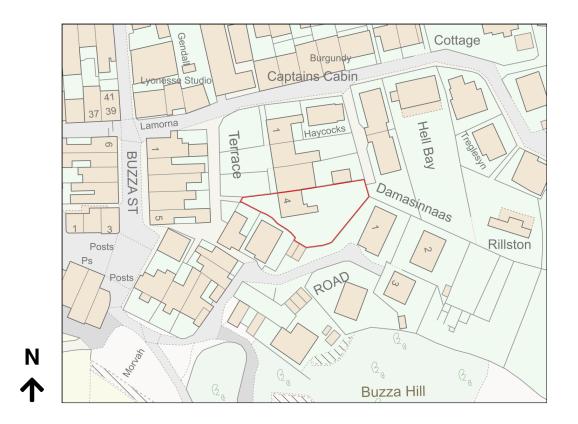

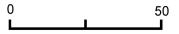

10m

20m

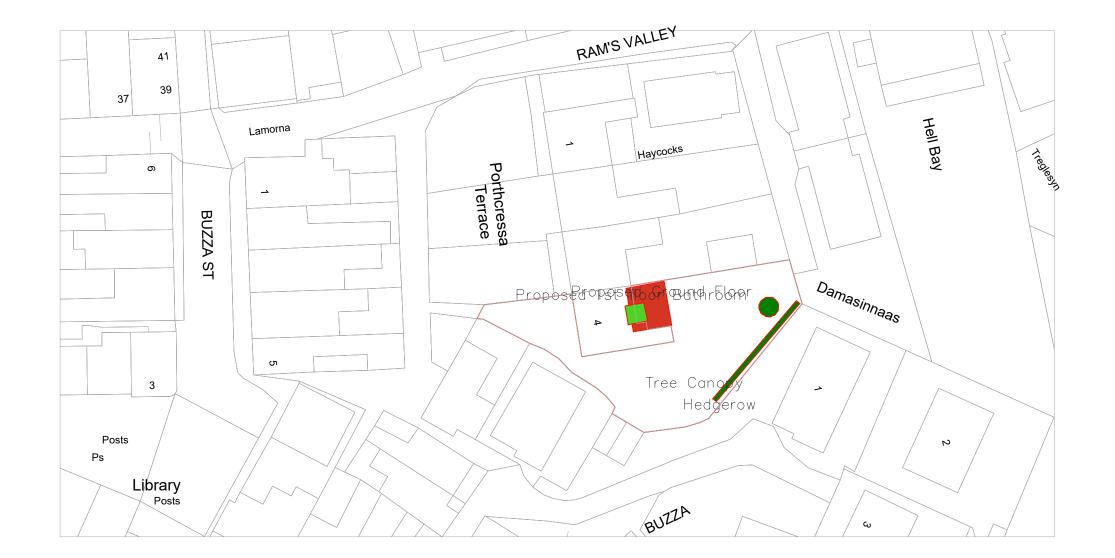

50m




ReQuestAPlan Map number: TQRQM24044161946527 Title: 4 Porthcressa Terrace Map Produced for: P&J Woodcock © Crown copyright and database rights 2024 OS 100042766 Project ID: Date of Purchase: 13-02-2024 1 Years subscription from 13-02-2024 for 1 workstation.

4 Porthcressa Terrace TR21 OJW

13.02.2024

1:500 @A3

DC_XXX_000_06101_P01

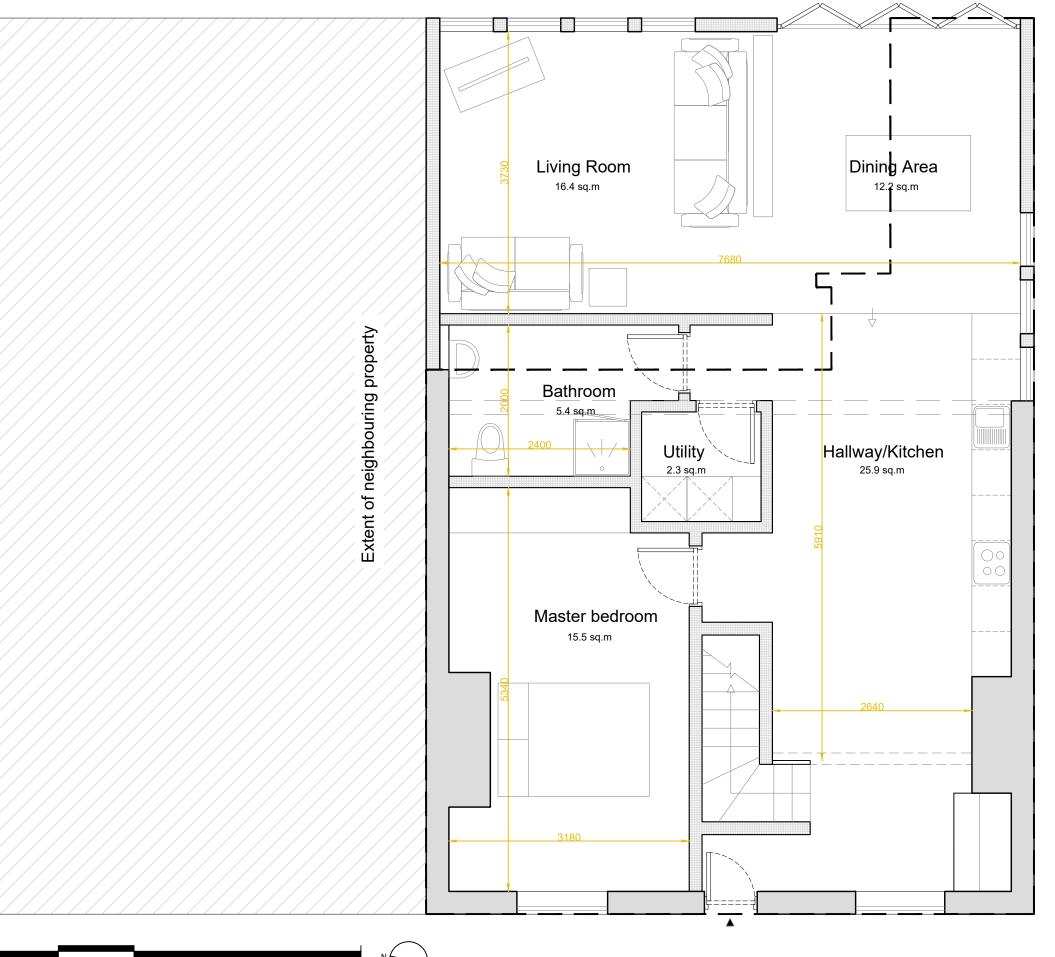

1m


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RECEIVED By Liv Rickman at 11:42 am, Feb 16, 2024

APPROVED By Lisa Walton at 10:14 am, Apr 12, 2024

> Line of existing property - -- --

4 Porthcressa Terrace	
TR21 OJW	
25.01.2024	
Proposed Plans	
Ground Floor	1:50 @A3
DC_XXX_000_02101_P02	

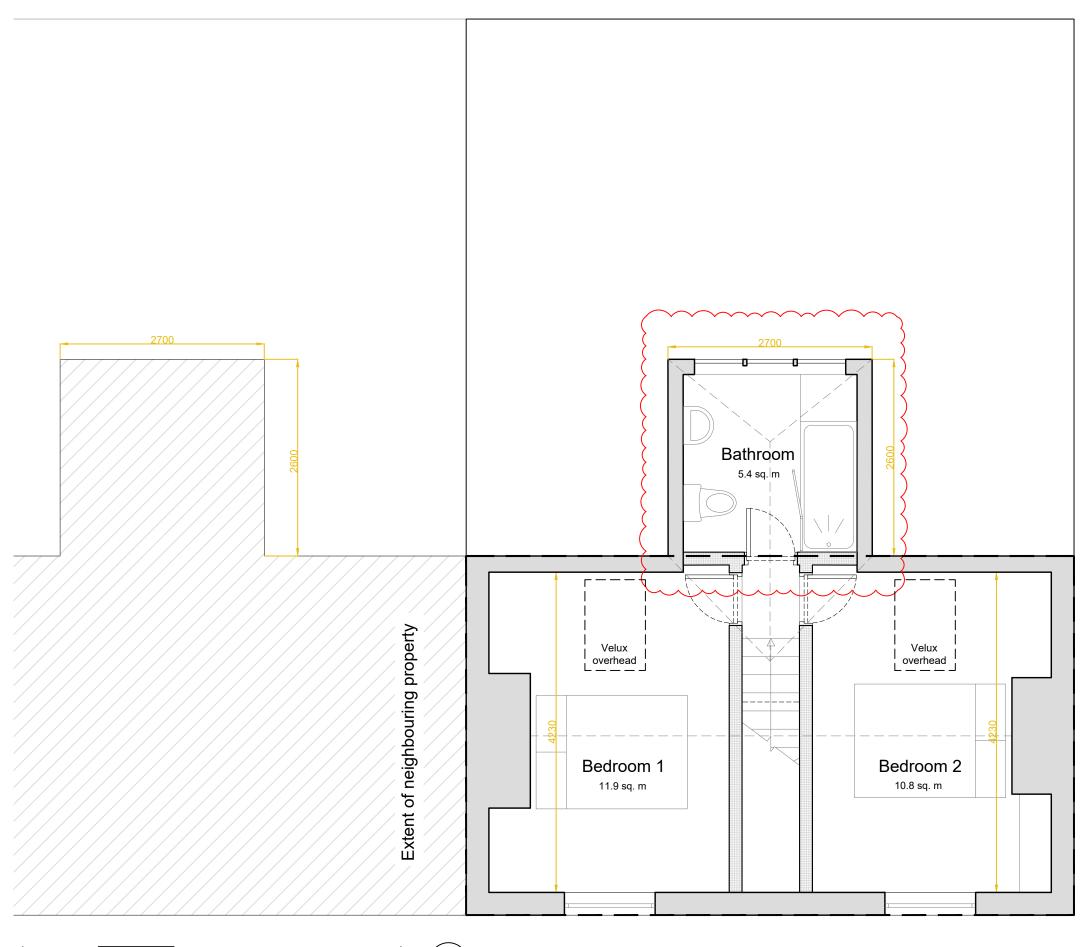

2m

1m


APPROVED

By Lisa Walton at 10:14 am, Apr 12, 2024

RECEIVED By Liv Rickman at 11:44 am, Feb 16, 2024

---- Line of existing property

4 Porthcressa Terrace	
TR21 OJW	
25.01.2024	
Proposed Plans	
First Floor	1:50 @A3
DC_XXX_001_02102_P02	

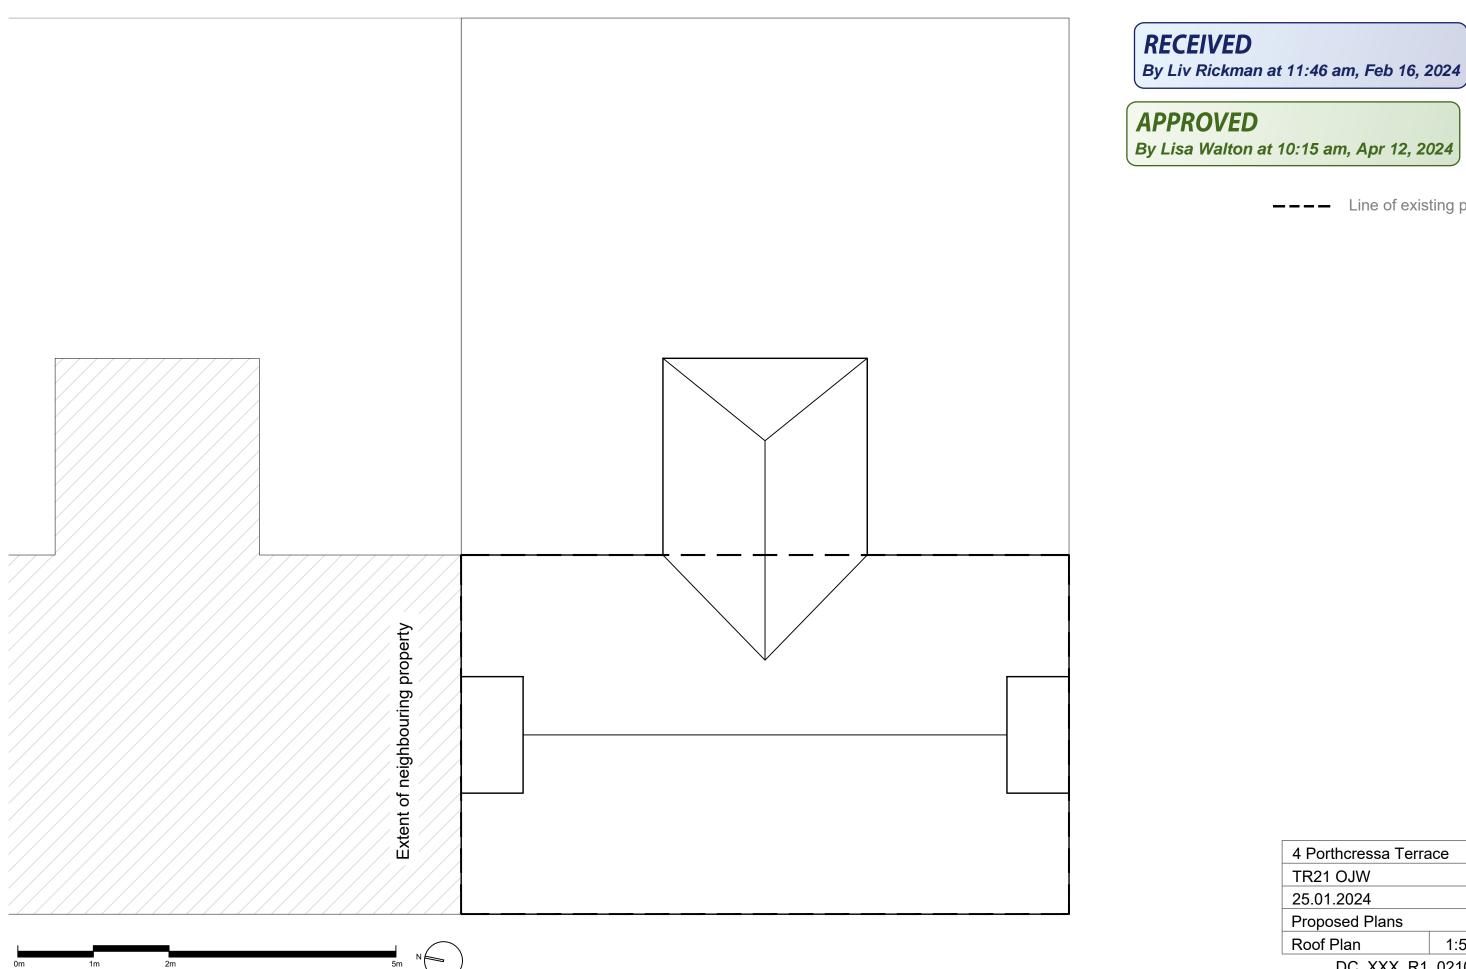

--- Line of existing property

4 Porthcressa Terrace	
TR21 OJW	
25.01.2024	
Proposed Plans	
Roof Plan	1:50 @A3
DC_XXX_R1_02103_P01	

RECEIVED


By Liv Rickman at 4:48 pm, Apr 08, 2024

APPROVED

By Lisa Walton at 10:15 am, Apr 12, 2024

2m



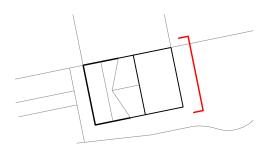

---- New proposal

4 Porthcressa Terrace		
TR21 OJW		
04.05.2024		
Proposed Elevation		
Rear Elevation	1:50 @A3	
DC_ZZZ_XXX_04101_P03		


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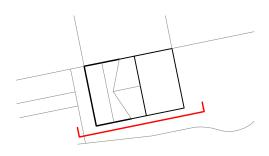
By Liv Rickman at 4:49 pm, Apr 08, 2024

APPROVED

By Lisa Walton at 10:29 am, Apr 12, 2024

2m



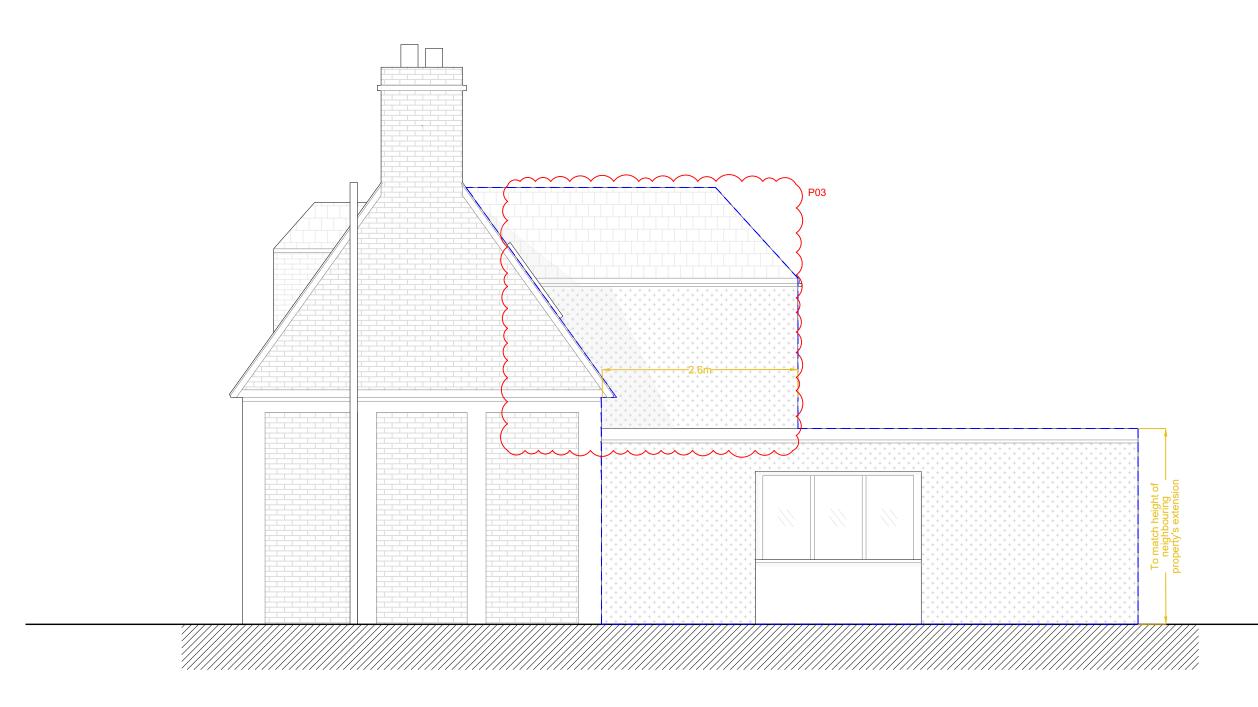

---- New proposal

4 Porthcressa Terrace		
TR21 OJW		
05.04.2024		
Proposed Elevation		
Side Elevation	1:50 @A3	
DC ZZZ XXX 04102 P03		

Revised Design and access statement

4 Porthcressa Terrace

Proposal.

To replace wet laid scantle slate roof on rear elevation with dry laid 10x20 Spanish slate secured with stainless steel clips. This will match in with the remaining properties in the terrace. The extended rear 1st floor dormer will create a much-needed 1st floor bathroom the service the 2 bedrooms on the 1st floor.

The ground floor extension will be timber frame with a white cement render as the current extension is and the gable end of the current property will be painted white to match.

The entire property will be insulated Including roof and cavity insulation during the remodelling work. The plumbing in both bathrooms will incorporate water saving measures and rainwater collection for garden use.

PRELIMINARY ROOST ASSESSMENT (PRA)

4 PORTHCRESSA TERRACE, HUGH TOWN, ST MARY'S, ISLES OF SCILLY



Client: Jennie Woodcock Our reference: 23-10-1 Planning reference: Produced in advance of submission Report date: 28th October 2023 Author: James Faulconbridge BSc (Hons), MRes, MCIEEM Contact: ios.ecology@gmail.com

Executive Summary

Bats - Results and Findings

The preliminary roost assessment (PRA) survey concluded that there was **negligible bat roosting potential** in relation to the structures to be impacted by the proposed works. This assessment relates solely to those aspects of the structure within the scope of the survey – it does not represent a comprehensive assessment of the property.

Whilst a negligible potential is concluded, it is noted that there is a small chance of opportunistic/transient use of individual discreet features. This potential is not sufficient to justify further surveys or significant constraints to works, but should be taken into account in accordance with the precautionary principle.

This judgement was reached in accordance with the survey methodologies and evaluation criteria outlined in the Bat Surveys for Professional Ecologists: Good Practice Guidelines 4^{th} edition¹

Bats - Further Survey Requirements

No further surveys are recommended – the PRA conclusion does not require further survey information with regards to bats in order to inform a planning application.

Bats - Recommendations

Standard good practice and vigilance should be observed by the contractors undertaking the works in acknowledgement that bats are transient in their use of roosting opportunities and may explore potential locations, especially if the condition of structural features were to change. A specific methodology is provided in Appendix 1.

A Planning Condition requiring compliance with the Precautionary Method of Works (PMW) outlined in Appendix 1 could be attached to a Decision Notice. If so, it is recommended that this should be compliance only – no further information would be required as the methodology outlined in the PMW is comprehensive.

If the applicant wishes to provide biodiversity enhancement, bat boxes could be erected on the gable of the dwelling. Guidance on suitable specifications is provided.

Nesting Birds - Results and Findings

There is a minor risk of individual bird species finding occasional nesting habitat associated with the building or proximate vegetation, such as the adjacent apple tree, though no evidence was noted at the time of survey.

Nesting Birds - Recommendations

Works should take account of the minor residual risk of species such as wren or robin making use of nesting opportunities during the breeding season.

If the applicant wishes to provide biodiversity enhancement, nest boxes could be erected either on the dwelling or within the residential garden. Guidance on suitable specifications is provided.

¹ Collins, J. (ed.) (2023) Bat Surveys for Professional Ecologists: Good Practice Guidelines (4th edition). The Bat Conservation Trust, London

PRELIMINARY ROOST ASSESSMENT (PRA)

Planning Authority:	Location:	Planning Application ref:
Isles of Scilly	SV 90545 10457	Report produced in support of application

Planning application address:

4 Porthcressa Terrace, Hugh Town, St Mary's, Isles of Scilly

Proposed development:

The proposed works were identified by the client and accord with the documentation submitted in support of the application. These involve:

- 1) The removal of existing flat-roof extension to the east of the main property;
- 2) Re-roofing the eastern aspect of the property;
- 3) Construction of a new two-storey extension on the eastern aspect of the property which would tie in with the existing roof.

Building references:

The structures under assessment comprise three distinct elements:

- Main House;
- Flat-roof extension;
- Water Tank enclosure.

These structural elements are identified in the plans provided in Appendix 1.

Name and licence number of bat-workers carrying out survey:

James Faulconbridge (2015-12724-CLS-CLS)

Preliminary Roost Assessment date:

The visual inspection was undertaken on 19th October 2023 in accordance with relevant Best Practice methodology².

Local and Landscape Setting:

The property is situated within the residential area of Hugh Town in St Mary's in the Isles of Scilly.

The land use immediately surrounding the property comprises dense residential development with generally small gardens although there is a more developed areas of green space to the immediate west of the properties. The shoreline of Porthcressa Beach lies close to the south of the property with the green space of the allotments, playground and setting of Buzza Tower close by to the east.

Three records of common pipistrelle roosts are identified in relatively close proximity to the property – these relate to individual bats utilising features such as hanging slates around

² Collins, J. (ed.) (2023) Bat Surveys for Professional Ecologists: Good Practice Guidelines (4th edition). The Bat Conservation Trust, London

dormer windows.

Building Description(s):

The property is an end-terrace, two-storey, residential house. It comprises the main dwelling, along with a flat-roof extension on the eastern aspect. A water tank enclosure is situated on the edge of the flat-roof extension. These distinct structural components are identified in Map 2 in Appendix 1.

Main House

The main dwelling is brick-built with a pitched, wet-laid scantle tiled roof on the eastern aspect. The western aspect of the roof has been replaced with dry-laid slate tiles and is of more recent construction. The proposals would not directly or indirectly impact the western aspect of the property, therefore no further consideration of this aspect is provided in this assessment.

The roof tiles on the eastern aspect are generally in good condition and any gaps present are too small for access by bats. Minor gaps occur at the apex of the dormer and at a ridge tile on the southern edge of the aspect – these appear superficial through inspection with close-focusing binoculars. The join between the roof of this property and the adjacent 3 Porthcressa Terrace is marked by a low concrete parapet – no gaps or other features are noted associated with this feature. There is a concrete chimney at each edge of the roof under consideration – these appear well-sealed and in good condition.

The loft space was inspected throughout – this is a small space built above the collar of the Aframe timbers with the living space built into the lower part of the roof. The loft is boarded out above the rafters and appears very well sealed. There is no insulation present between the joists. The loft space was densely cobwebbed with dusty, old webs indicating no recent flight by bats within the space. A full inspection of the floor identified no droppings or other evidence of bats – individual small rodent droppings were noted.

As the loft space is well-boarded and no evidence of internal roosting was identified, the potential for indirect impacts of works on the eastern aspect affecting un-surveyed features on the western aspect does not require further consideration.

There is a central dormer window within the roof – this has well-sealed hanging tiles on the sides with a scantle-tiled pitched roof above. The valley joining the pitches appears generally well sealed with lead flashing though minor lifted gaps occur both here and below the window. The gap beneath the window has been sealed with expanding foam in the past – this appears to provide a tight seal to this cavity at present, but the condition could change due to the nature of the filling.

Minor gaps occur behind the drop tiles on the southern gable of the building – these appear superficial through inspection with a torch and close-focusing binoculars.

The fascias on the eastern aspect have minor gaps but the tie-in with the flat-roof extension immediately below this would prevent a clear fly-in and would significantly reduce the suitability of a feature here.

No evidence of current or historic use by bats or nesting birds was identified during the survey.

Flat-roof extension

A flat-roof single-storey extension is attached on the eastern aspect of the property. This is block-built and uPVC-clad in places. No features were noted associated either with the pointing or the cladding. Window frames are well-fitted with no gaps noted at the edges.

The fascias throughout the flat-roof extension are well-fitted and tightly sealed. In places, there are small gaps behind the roof cladding where it overlaps the top of the wall; however the guttering attached to the fascia below would prevent a clear fly-in and would significantly

reduce the suitability of a feature here.

Water Tank

There is a flat-roofed water tank enclosure attached on the eastern edge of the flat-roof extension. This also houses a small shed/garage unit which was accessed and inspected and found to provide no roosting opportunities.

The structure did not have any gaps, cracks or other features which would provide roosting opportunities for bats.

Garden Shed

A small, pre-fab timber garden shed is present within the footprint of the proposed development and is likely to either be moved or removed to facilitate the works.

It was fully inspected and no suitable roosting opportunities for bats were noted.

Survey Limitations

It was not possible to comprehensively inspect all features such as lead flashing around the dormer windows due to the lack of access at height. However the majority of the relevant features could be fully inspected with binoculars. This residual limitation can be addressed through a Precautionary Method of Works (PMW).

There were no other significant limitations to access or survey inspection which might affect the evidence base or subsequent conclusions of this survey.

Assessment of Potential for use by Roosting Bats

No evidence of current or historic use by bats was identified during the survey and an overall **negligible potential** was determined; however it is noted that there is a small residual risk of opportunistic/transient use of the features noted.

This assessment relates only to the eastern aspect of the main dwelling; and the flat-roof extensions.

Recommendations and Justification (Bats):

No further surveys are recommended – the conclusion of **negligible potential** related to the structures to be impacted does not require any further information with regards to bats in order to inform a planning application.

Standard good practice and vigilance should be observed by the contractors undertaking the works in acknowledgement that bats are transient in their use of roosting opportunities and may explore potential locations. The potential for individual common pipistrelle bats to make use of minor opportunities associated with listed features should be taken into account during works. These features are:

- The lead flashing associated with the dormer window;
- Any minor gaps beneath roof/ridge tiles which may be present, or may arise due to change of condition between the time of survey and the time of works;
- Minor superficial gaps associated with drop-tiles on the southern gable;
- Fascias or overlapping roof coverings with minor gaps which are obstructed by guttering.

At the discretion of the Planning Authority, a compliance condition could be included in any Planning Application approval requiring that works proceed in line with the PMW requirements outlined in Appendix 1 of this report. This is in order to ensure that roosting bats are not impacted by the proposed works.

If the applicant wishes to provide biodiversity enhancement, the position of the southern gable facing onto the garden with an apple tree would offer an ideal location to install a bat box. This should be positioned above 3m from the ground to minimise the risk of predation. An open-based box design would ensure that it would not require cleaning. The location and aspect would be optimal for bats such as common pipistrelle which is the dominant species present on the island and the most likely species to use the environs for foraging and roosting. The proximity of the gable to existing vegetation would secure a vegetated fly-in/out habitat.

A suitable box could be purchased or constructed following freely available plans. Kent Bat Box style boxes are slim easy to construct from appropriate timber using the plans provided at:

http://www.kentbatgroup.org.uk/kent-bat-box.pdf

Assessment of Potential for use by Nesting Birds

It is considered that the relevant structures described in this report provide **low potential** for use by nesting birds; however there is a minor residual risk of species such as wren or robin making use of minor niches to build a nest. There is also a risk of nesting birds within adjacent vegetation – especially the apple tree in close proximity on the southern gable.

Recommendations and Justification (Birds):

Timing of Works

Works affecting the roof should be undertaken outside of the breeding season which runs from March – September inclusive, where practicable. This would provide the most robust means of avoiding risk of impact to nesting birds.

Pre-commencement Inspection

If this is not possible, then contractors should visually inspect the work area internally and externally before they are affected by the works, in order to confirm that no nests are present. In the unlikely event that a bird nest is present, it must be left undisturbed until chicks have fledged the nest, at which point works can proceed.

Care must also be taken to ensure that the works do not cause disturbance or damage to proximate nesting areas through indirect impacts including vibration, noise or contractor presence. This includes adjacent parts of the building, as well as vegetation within the garden and boundary hedges.

Enhancement Opportunities

There is no requirement to mitigate for loss of nesting habitat for breeding birds as no nesting habitat would be removed; however if the applicant wished to provide biodiversity enhancement measures, this could be achieved through the erection of bird boxes on the residential property or within the garden.

House sparrows nest communally and nest boxes could accommodate this, either through the installation of a single purpose-built nest box comprising several individual chambers with separate entrances, or the installation of 3+ nest boxes in close proximity. Nest boxes suitable for hole-dwelling species such as blue tits, or open-fronted boxes for species such as blackbird and robin also have a high likelihood of occupation.

Boxes should be mounted on a wall or tree if possible, at a height of at least 3m above the ground with an entrance clear of vegetation/other features which may put them at risk of predation from cats.

Boxes can be sourced online, or can be constructed on site using methodology and specifications provided by the RSPB:

Sparrows: https://www.rspb.org.uk/get-involved/activities/give-nature-a-home-in-your-garden/garden-activities/createasparrowstreet/

Other Species: https://www.rspb.org.uk/fun-and-learning/for-families/family-wild-challenge/activities/build-a-birdbox/

Signed by bat worker(s):

Date: 28th October 2023

APPENDIX 1

PRECAUTIONARY METHOD STATEMENT WITH REGARDS TO BATS

The purpose of this Method Statement is to ensure that proposed works can proceed where presence of bats has been determined to be unlikely, but a precautionary approach is still advisable. It has been determined that direct harm to roosting bats during the proposed works would be highly unlikely.

Contractors should, however, be aware of **their own legal responsibility with respect to bats**:

Relevant Legislation regarding Bats

The Conservation of Habitats and Species Regulations 2017, or the 'Habitat Regulations 2017', transposes European Directives into English and Welsh legislation. Under these regulations, bats are classed as a European Protected Species and it is, therefore, an offence to:

- Deliberately kill, injure or capture bats;
- Deliberately damage or destroy bat roosts.

A bat roost is commonly defined as being any structure or place that is used as a breeding site or resting place, and since it may be in use only occasionally or at specific times of year, a roost retains such a designation even if bats are not present.

Bats are also protected from disturbance under Regulation 43. Disturbance of bats includes in particular any disturbance which is likely:

- (a) To impair their ability -
 - to survive, to breed or reproduce, or to rear or nurture their young; or
 - in the case of animals of a hibernating or migratory species, to hibernate or migrate; or
- (b) To affect significantly the local distribution or abundance of the species to which they belong.

Bats also have limited protection under the Wildlife and Countryside Act 1981 (as amended) and the Countryside Rights of Way Act 2000 (as amended). It is, therefore, an offence to:

- Intentionally or recklessly destroy, damage or obstruct any structure or place which a bat uses for shelter or protection.
- Intentionally or recklessly disturb bats whilst occupying any structure or place used for shelter or protection.

Contractors should be aware of **where bats are most likely to be found in respect to the roof to be replaced**:

Lead Flashing

Minor lifted sections occur within the lead flashing where the dormers meet the roof tiles below, and in the valley between the pitch of the dormer and the adjacent roof.

If these are to be removed as part of the works, locations where the flashing is lifted should be exposed carefully such that if any bats were present behind the lifted element, they would not be crushed or otherwise injured by the operation. Contractors should satisfy themselves that no bats are present before proceeding with works in these areas.

Dormer Window Frame

There is a minor gap below the dormer window frame which appears sealed at the time of survey, but may deteriorate before works take place. This area should be fully inspected visually before works commence in order to confirm that no bats are present.

Roof/Ridge Tiles

There are minor gaps noted beneath individual ridge tiles on the apex of the dormer and the southern edge of the main roof, close to the chimney. These appear superficial but it is possible that minor niches may occur. In addition, further gaps may appear if the condition of tiles deteriorates between the time of survey and the time of works.

The following protocol also applies to the drop tiles on the southern gable.

If there are gaps beneath tiles, these tiles and those adjacent to them should be lifted carefully in such a way that if any bats were roosting beneath, they would not be crushed or injured by the action. The undersides of the tiles should be carefully checked before being set aside. Contractors should satisfy themselves that no bats are present before proceeding with works in these areas.

Fascias

There are occasional gaps where the fascias and the overhang of the roof covering meet the walls. Where these are to be removed or impacted as part of the proposed works, they should be carefully removed and the gaps behind them exposed in such a way that, in the highly unlikely event that bats are present, they are not injured or killed by the action. Contractors should satisfy themselves that no bats are present before proceeding with works in these areas. Contractors should be aware of **the process to follow in the highly unlikely event of finding bats** or evidence indicating that bats are likely to be present:

If bats are identified, works should cease and the named ecologist contacted immediately for advice.

If the bat is in a safe situation, or a situation which can be made safe, they should remain undisturbed.

Only if the bat is in immediate risk of harm can the bat be moved with care and using a gloved hand. This is a last resort and should only be undertaken for humane reasons if the bat is at immediate risk of harm **and** if the ecologist cannot be contacted for advice.

APPENDIX 2

LOCATION PLAN AND PHOTOGRAPHS



Map 01 – Illustrating location of property within the local environs (red circle). Reproduced in accordance with Google's Fair Use Policy.



Map 02 – Showing the different elements of the buildings.



Photograph 1: Showing the property – the main property of 4 Porthcressa Terrace spans the length between the two chimneys on the left-hand side The flat-roof extension can be seen in the foreground with the enclosed water-tank.



Photograph 2: Showing the roof structure – this is largely well-sealed with no gaps noted; however occasional minor gaps are noted including the gap in the ridge highlighted.



Photograph 3: Showing the southern gable of the property – there superficial gaps behind the droptiles on the eastern aspect can be seen on the righthand side. Those on the western aspect would not be affected.



Photograph 4: Showing the loft space with boarding visible between the rafters.



Photograph 5: Showing the flat-roof extension with uPVC cladding.



Photograph 5: Showing the flat-roof extension with Photograph 6: Showing the enclosed water tank.

RECEIVED By Liv Rickman at 3:30 pm, Feb 14, 2024

APPROVED By Lisa Walton at 10:32 am, Apr 12, 2024

4 Porthcressa Terrace

Site waste Management Plan.

Contractor to be announced

Blockwork and existing slate to be crushed and recycled locally

Timber To be de-nailed and reused where appropriate where timber cannot be reused it will be disposed of at the local waste processing facility.

Old UPVC windows offered locally for cold frames etc failing that disposed of at local waste processing facility.

Old GRP roof materials to be disposed of at local waste processing facility